
30'X30' CARRIAGE BARN KIT FOR:

JOE & KATHY SALVADOR


31 LAKE YIEW ROAD SHUTESBURY, MA 01072

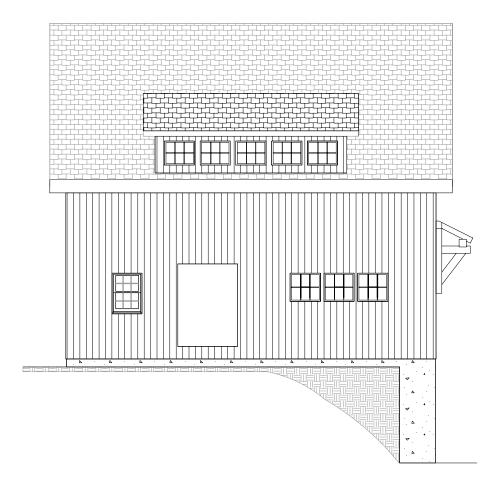

30' x 30' POST & BEAM CARRIAGE BARN KIT

REVISION DATE: 11/10//2021 REVISION #:1



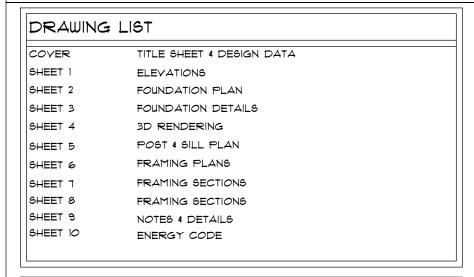

THE BARN YARD

MANUFACTURING & DESIGN FACILITY
9 VILLAGE ST.
ELLINGTON, CT 06029
860.454.9103

SHOWCASE LOCATIONS

120 WEST RD.

ELLINGTON, CT 06029 BETHEL, CT 06801


860.896.0636 203.740.7433

www.greatcountrygarages.com CT LICENSE * 558916 MA LICENSE * 127550


NOTE:
ELEVATIONS & RENDERINGS
ARE ARTISTS CONCEPTIONS.
COLOR AND OPTION STYLES
MAY DIFFER FROM ACTUAL
CONSTRUCTION.

PROJECT NO. 1230

PRINT DATE: 11,10,2021

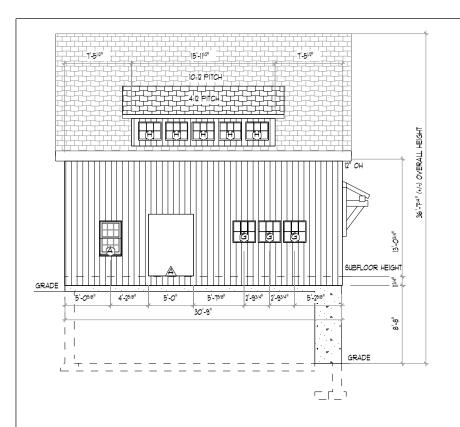



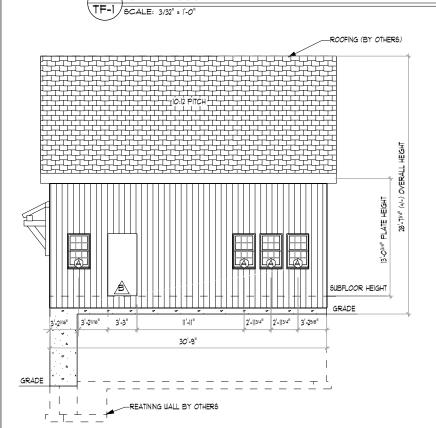

DOOR SCHEDULE- SUPPLIED BY CUSTOMER									
DOOR 1	DOOR MANUFACTURE: CUSTOM								
LETTER			RGH, OPG (WXH)	HINGE	SWING	COLOR			
A	1	5'-0"XT'-0" W/ SIDE LIGHT	5'-0" x 6'-10 1/2"	LEFT	IN	N/A			
É	2	3'-0"X1'-0" ENTRY DOOR	3'-3"x 6'-10 1/2"	LEFT	IN	N/A			

	WINDOW SCHEDULE-SUPPLIED BY CUSTOMER									
WINDOW	WINDOW MANUFACTURE: CUSTOM									
LETTER	QTY	MODEL	GRILL	TEMP,	EGRE66	RGH, OPG (WxH)	COLOR			
(4)	7	CUSTOM DH	6/6	NO	NO	2'-6 1/4 × 3'-10 7/8"	N/A			
₿	2	CUSTOM CASEMENT LEFT HINGE	3/4	YES	YES	2'-6 1/8"×3'-8 7/8"	N/A			
0	2	CUSTOM CASEMENT RIGHT HINGE	3/4	YES	YES	2'-6 1/8"×3'-8 7/8"	N/A			
0	2	CUSTOM CASEMENT FIXED	3/4	YES	NO	2'-6 1/8"×3'-8 7/8"	N/A			
Ê	6	CUSTOM PICTURE	4/4	NO	NO	3'-6 1/2" × 4'-4 7/8"	N/A			
Ð	2	CUSTOM 8' BOW TOP	11/3	NO	NO	8'-0 1/2"×2'-7 5/8"	N/A			
G	3	CUSTOM AWNING	3/2	NO	NO	2'-6 1/4"×2'-4 1/4"	N/A			
\oplus	5	CUSTOM AWNING	3/2	NO	NO	2'-6 1/4"×2'-0 1/4"	N/A			

BUILDING	MATERIAL SCHEDULE	
ITEM	FINISH/COLOR	
ROOF ASSEMBLY		
	10.5" SIP PANEL	NONE
ROOF DECKING	IX8 TEG PINE V-GROOVE DECKING	NONE
WALL ASSEMBLY		
INSULATION	4.5" SIP PANEL	NONE
FRAMING	2×6	NONE
INT, LAYER SIDING	IX8 KILN DRIED SHIPLAP PINE	NONE

GCTF CONSTRUCTION SCOPE OF SERVICES

SUPPLY:


- STRUCTURAL TIMBER FRAME COMPONENTS IX8 T&G ROOF DECKING IX8 T&G DECKING 2ND FLOOR

- INTERIOR LAYER IX8 PINE - STRUCTURAL INSULATED PANELS (SIP)

EXCLUSIONS INCLUDE BY ARE NOT LIMITED TO:


- FOUNDATION
- STRUCTURAL STEEL
- WALL & FLOOR FRAMING
- DOORS, WINDOWS, SIDING & ROOFING
- EXTERIOR DOOR & WINDOW TIMBER CLADDING

PER CONTRACT NO. 7230 AND ANY APPROVED CHANGE ORDERS

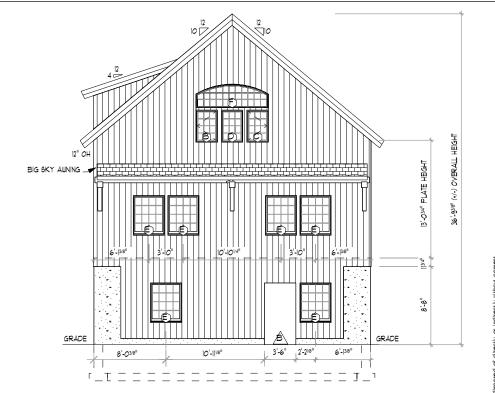

3 RIGHT ELEVATION

TF-1 | SCALE: 3/32" = 1'-0"

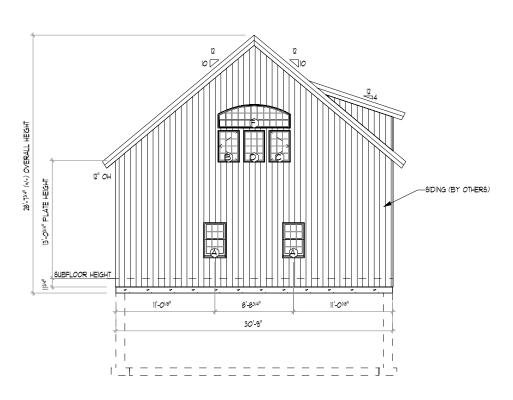

4 LEFT ELEVATION

TF-1 SCALE: 3/32" = 1'-0"



MANUFACTURING & DESIGN FACILITY
9 VILLAGE ST.
ELLINGTON, CT 06029
860,454,9103

121560 | ### 121560 | ### 1

BUILDING CODE: THE MASSACHUSETTS BUILDING RESIDENTIAL CODE 180 CMR NINTH EDITION. DESIGN NOTES:

DEAD LOADS: SECOND FLOOR: 15 PSF ROOF: 15 PSF

LIVE LOADS: SECOND FLOOR: 40 PSF ROOF: 20 PSF

ROOF: 40 PSF SNOW LOADS: WIND LOADS: BASIC WIND SPEED(Y): IIT MPH (3 SEC. GUST)

TIMBER NOTES:

EASTERN WHITE PINE SPECIES: GRADE: *2 OR BETTER

SURFACE: SIZING: CHAMFERS: FINISH: 646 1/2" UNDER ROUGH DIM. (6X6 = 1.5"X1.5") (NONE)

(NONE) FASTENER NOTES:

5 - BOLTS, NUTS, WASHERS: DIA, AS NOTED, GALVANIZED, GRADE A301

TIMBER FRAME: L TRADITIONAL MORTISE & TENON JOINERY W/ I" DIA, OAK PEGS AT

BEAM CONNECTIONS.

- TRADITIONAL WOOD CONNECTIONS TO BE SUPPLEMENTED BY

STRUCTURAL WOOD SCREWS AS NOTED.

REVISIONS / SUBMISSIONS


30'X30' CARRIAGE BARN KIT FOR JOE & KATHY SALVADOR 31 LAKE YIEW ROAD SHUTESBURY, MA 01072


DRAWING TITLE:


ELEVATIONS

11-10-21 AS NOTED DRWN BY TF-1 OF 10 EWS PROJECT ID

² REAR ELEVATION TF-1 SCALE: 3/32" = 1'-0"

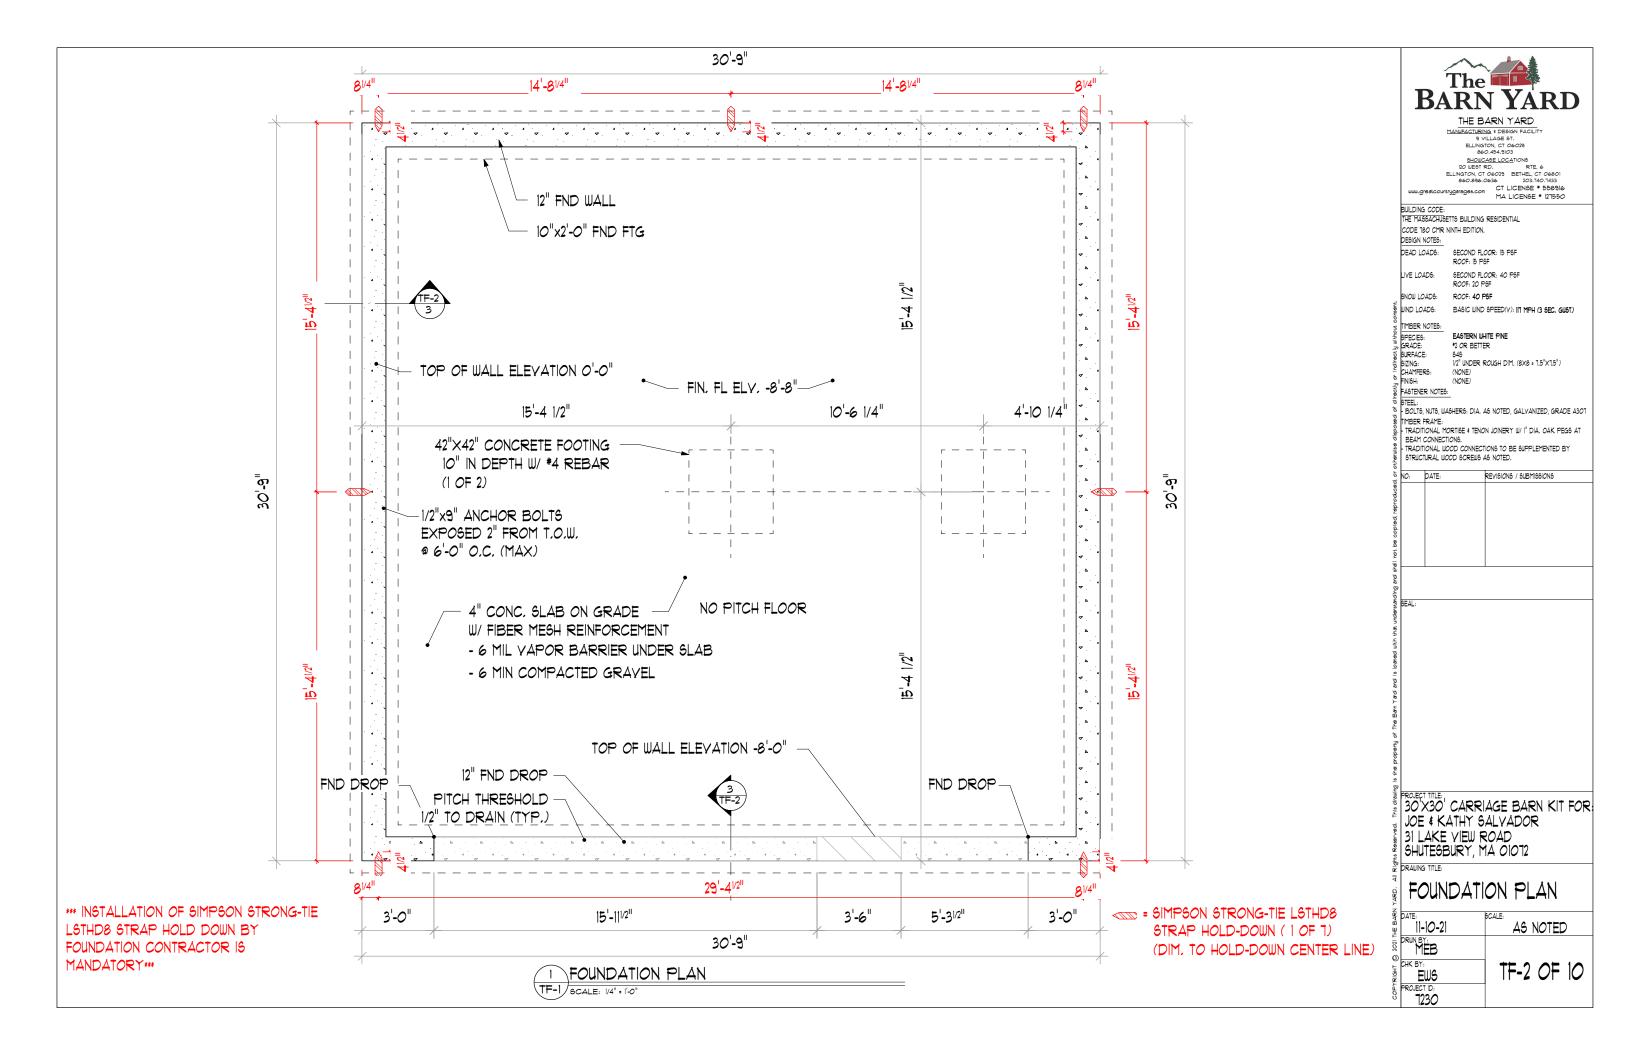

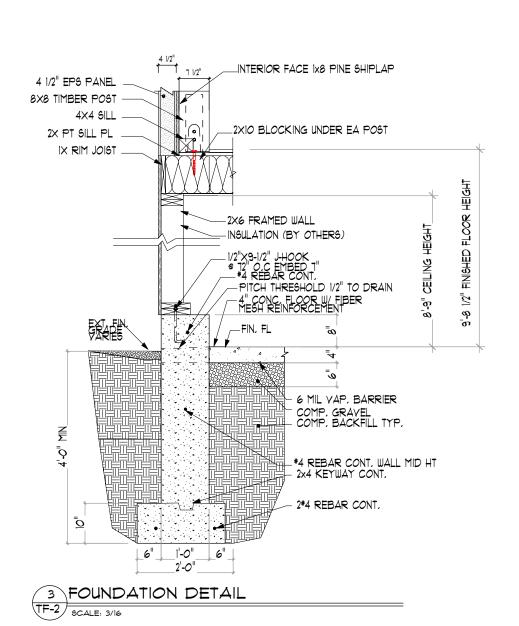

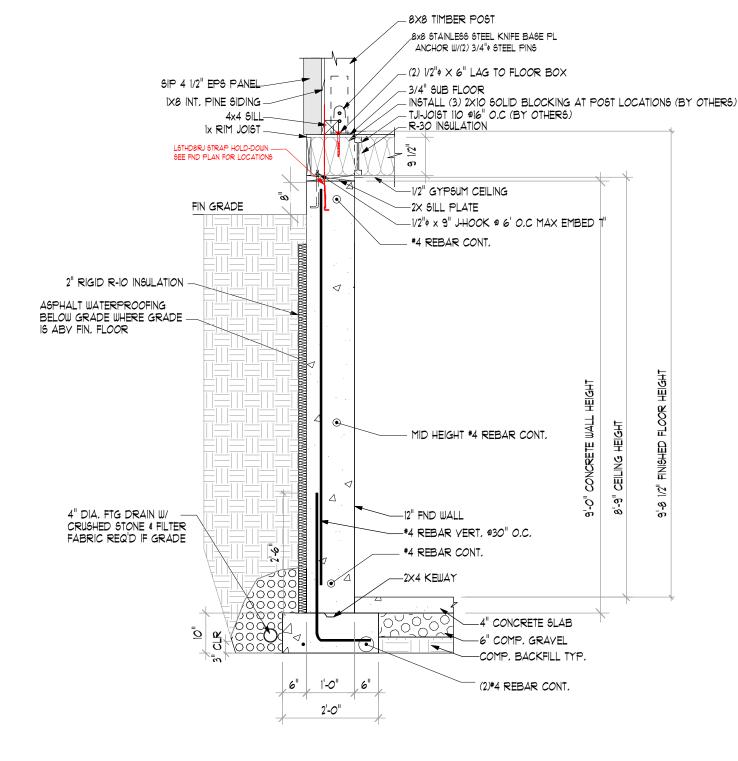

2 FOUNDATION DETAIL TF-2 SCALE: 1/4



THE BARN YARD

MANUFACTURING & DESIGN FACILITY 9 VILLAGE ST. ELLINGTON, CT 06029 860,454,9103

12560 | ### 12560 | ### 12

BUILDING CODE: THE MASSACHUSETTS BUILDING RESIDENTIAL CODE 180 CMR NINTH EDITION.

DESIGN NOTES: DEAD LOADS: SECOND FLOOR: 15 PSF

ROOF: 15 PSF

LIVE LOADS: SECOND FLOOR: 40 PSF ROOF: 20 PSF

ROOF: 40 PSF SNOW LOADS:

WIND LOADS: BASIC WIND SPEED(Y): IIT MPH (3 SEC. GUST)

TIMBER NOTES:

EASTERN WHITE PINE

SPECIES: GRADE: *2 OR BETTER

6URFACE: 1/2" UNDER ROUGH DIM. (8X8 = 7.5"X7.5")

CHAMFERS:

FASTENER NOTES:

5 | BOLTS, NUTS, WASHERS: DIA. AS NOTED, GALYANIZED, GRADE A301

IMBER FRAME: L TRADITIONAL MORTIGE & TENON JOINERY W/ I" DIA, OAK PEGG AT BEAM CONNECTIONS.

- TRADITIONAL WOOD CONNECTIONS TO BE SUPPLEMENTED BY

STRUCTURAL WOOD SCREWS AS NOTED,


REVISIONS / SUBMISSIONS


30'X30' CARRIAGE BARN KIT FOR JOE & KATHY SALVADOR 31 LAKE VIEW ROAD SHUTESBURY, MA 01072

DRAWING TITLE:

FOUNDATION DETAILS

11-10-21 AS NOTED DRWN BY: TF-3 OF 10 EWS PROJECT ID

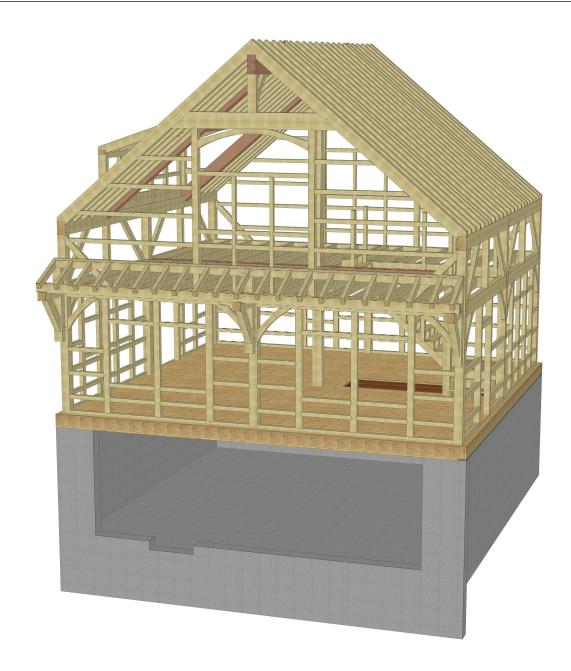

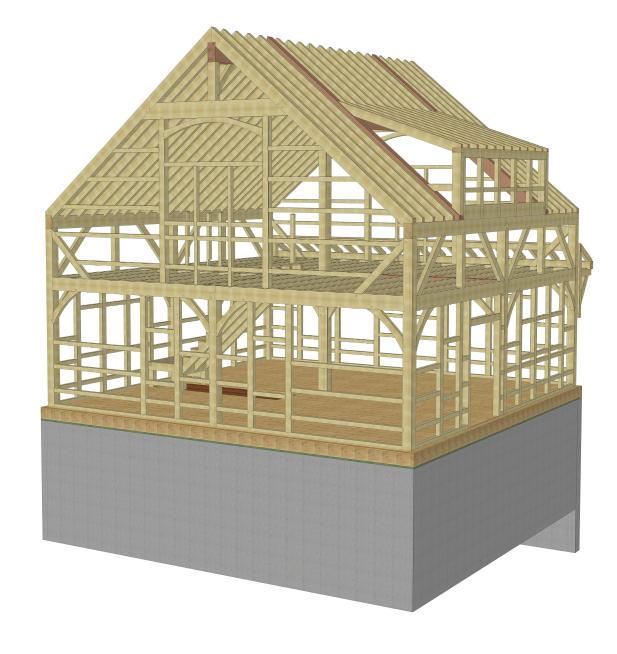

FRONT 3D RENDERING TF-3 SCALE: NTS

REAR 3D RENDERING
TF-3 SCALE: NTS

The
BARN YARD

THE BARN YARD

MANUFACTURING & DESIGN FACILITY
9 VILLAGE ST.
ELLINGTON, CT 06029
860.454,9103

860.494.3(0.5)

SHOULDASE ICCCATIONS
IND UBST RD. RTE. 6
ELLINGTON, CT 06039 BETHEL, CT 06001
860.294.093 1003.140.1433

TOT LICENSE * 558018

MA LICENSE * 127550

BUILDING CODE: THE MASSACHUSETTS BUILDING RESIDENTIAL CODE 180 CMR NINTH EDITION, DESIGN NOTES:

DEAD LOADS:

SECOND FLOOR: 15 PSF ROOF: 15 PSF LIYE LOADS:

SECOND FLOOR: 40 PSF ROOF: 20 PSF

SNOW LOADS: ROOF: 40 PSF MIND LOADS: BASIC WIND SPEED(V): IT MPH (3 SEC. GUST)

TIMBER NOTES:

EASTERN WHITE PINE

FINISH: (1)

FASTENER NOTES: *2 OR BETTER

545 1/2" UNDER ROUGH DIM. (6×6 = 1.5"×1.5") (NONE) (NONE)

8 FASI INNER NOTES:

| STEEL:
| DITEEL:
| DITEEL:
| BOLTS, NUTS, WASHERS: DIA, AS NOTED, GALVANIZED, GRADE A301
| IMBER FRAME:
| TRADITIONAL MORTISE & TENON JOINERY W/ | DIA, OAK PEGS AT
| BEAM CONNECTIONS.
| TRADITIONAL WOOD CONNECTIONS TO BE SUPPLEMENTED BY
| STRUCTURAL WOOD SCREWS AS NOTED.


REVISIONS / SUBMISSIONS


PROJECT TITLE: 30 X30 CARRIAGE BARN KIT FOR: JOE & KATHY SALVADOR 31 LAKE YIEW ROAD SHUTESBURY, MA 01072

DRAWING TITLE:

3D RENDERING

11-10-21 AS NOTED DRWN BY: CHK BY:
EWS
PROJECT ID:
1230 TF-4 OF 10

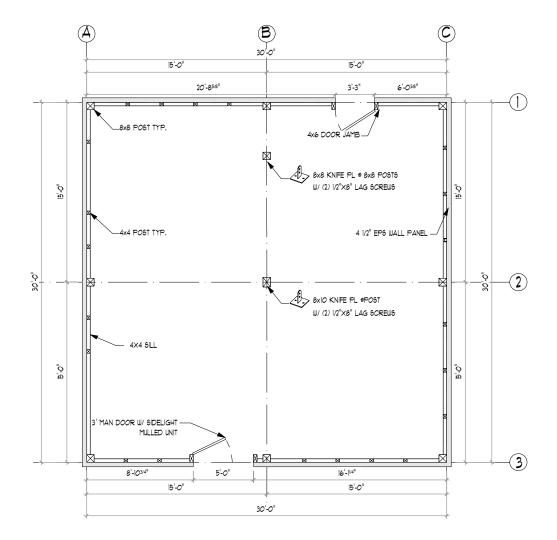

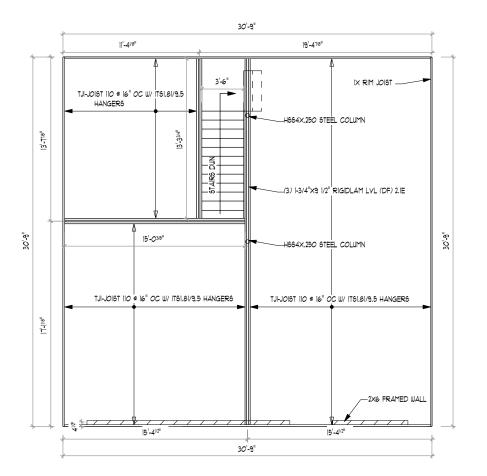

POST & SILL PLAN TF-4/SCALE: 1/8" = 1'-0"

IST FLOOR FRAMING PLAN TF-4 SCALE: 1/8" = 1'-0"



MANUFACTURING & DESIGN FACILITY
9 VILLAGE ST.
ELLINGTON, CT 06029
860.454,9103

BUILDING CODE: THE MASSACHUSETTS BUILDING RESIDENTIAL

CODE 180 CMR NINTH EDITION.

DESIGN NOTES: DEAD LOADS:

SECOND FLOOR: 15 PSF ROOF: 15 PSF LIVE LOADS:

SECOND FLOOR: 40 PSF ROOF: 20 PSF

SNOW LOADS: ROOF: 40 PSF

MIND LOADS: BASIC WIND SPEED(V): IIT MPH (3 SEC. GUST)

TIMBER NOTES:

EASTERN WHITE PINE *2 OR BETTER

SPECIES: 646 1/2" UNDER ROUGH DIM. (6X6 = 1.5"X1.5")

6URFACE: 6URFACE: 6IZING: CHAMFER6: FINI6H: (NONE) (NONE)

FASTENER NOTES:

6 TEEL:

BOLTS, NUTS, WASHERS: DIA, AS NOTED, GALVANIZED, GRADE A301

TIMBER FRAME:

TRADITIONAL MORTIGE & TENON JOINERY W/ I" DIA, OAK PEGS AT BEAM CONNECTIONS,
TRADITIONAL WOOD CONNECTIONS TO BE SUPPLEMENTED BY

STRUCTURAL WOOD SCREWS AS NOTED,


REVISIONS / SUBMISSIONS


PROJECT TITLE: 30 X30 CARRIAGE BARN KIT FOR: JOE & KATHY SALVADOR 31 LAKE YIEW ROAD SHUTESBURY, MA 01072


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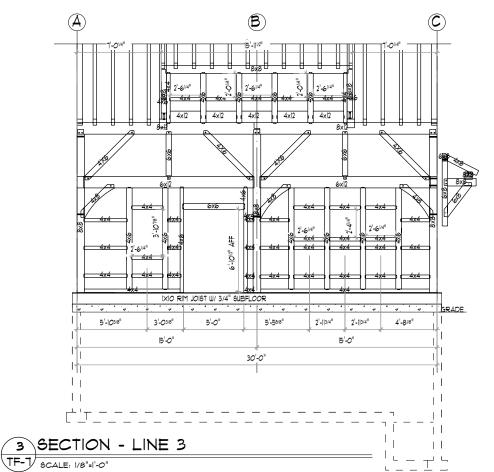
POST & SILL PLAN


11-10-21 AS NOTED DRWN BY: CHK BY:
EWS
PROJECT ID:
7230 TF-5 OF 10



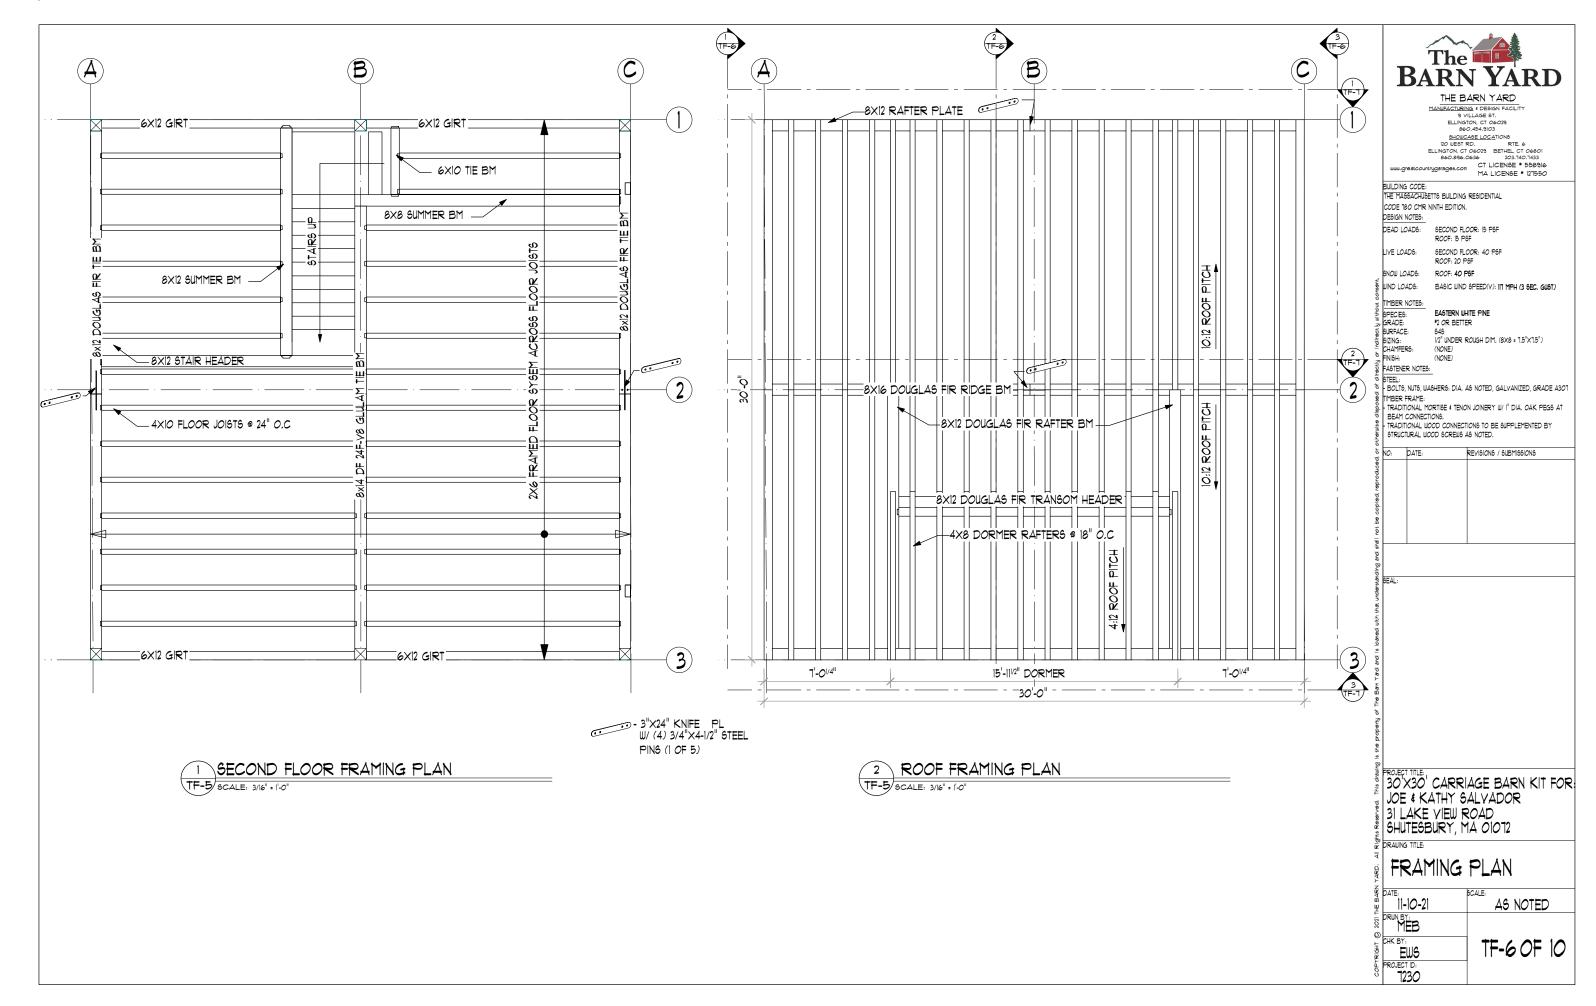

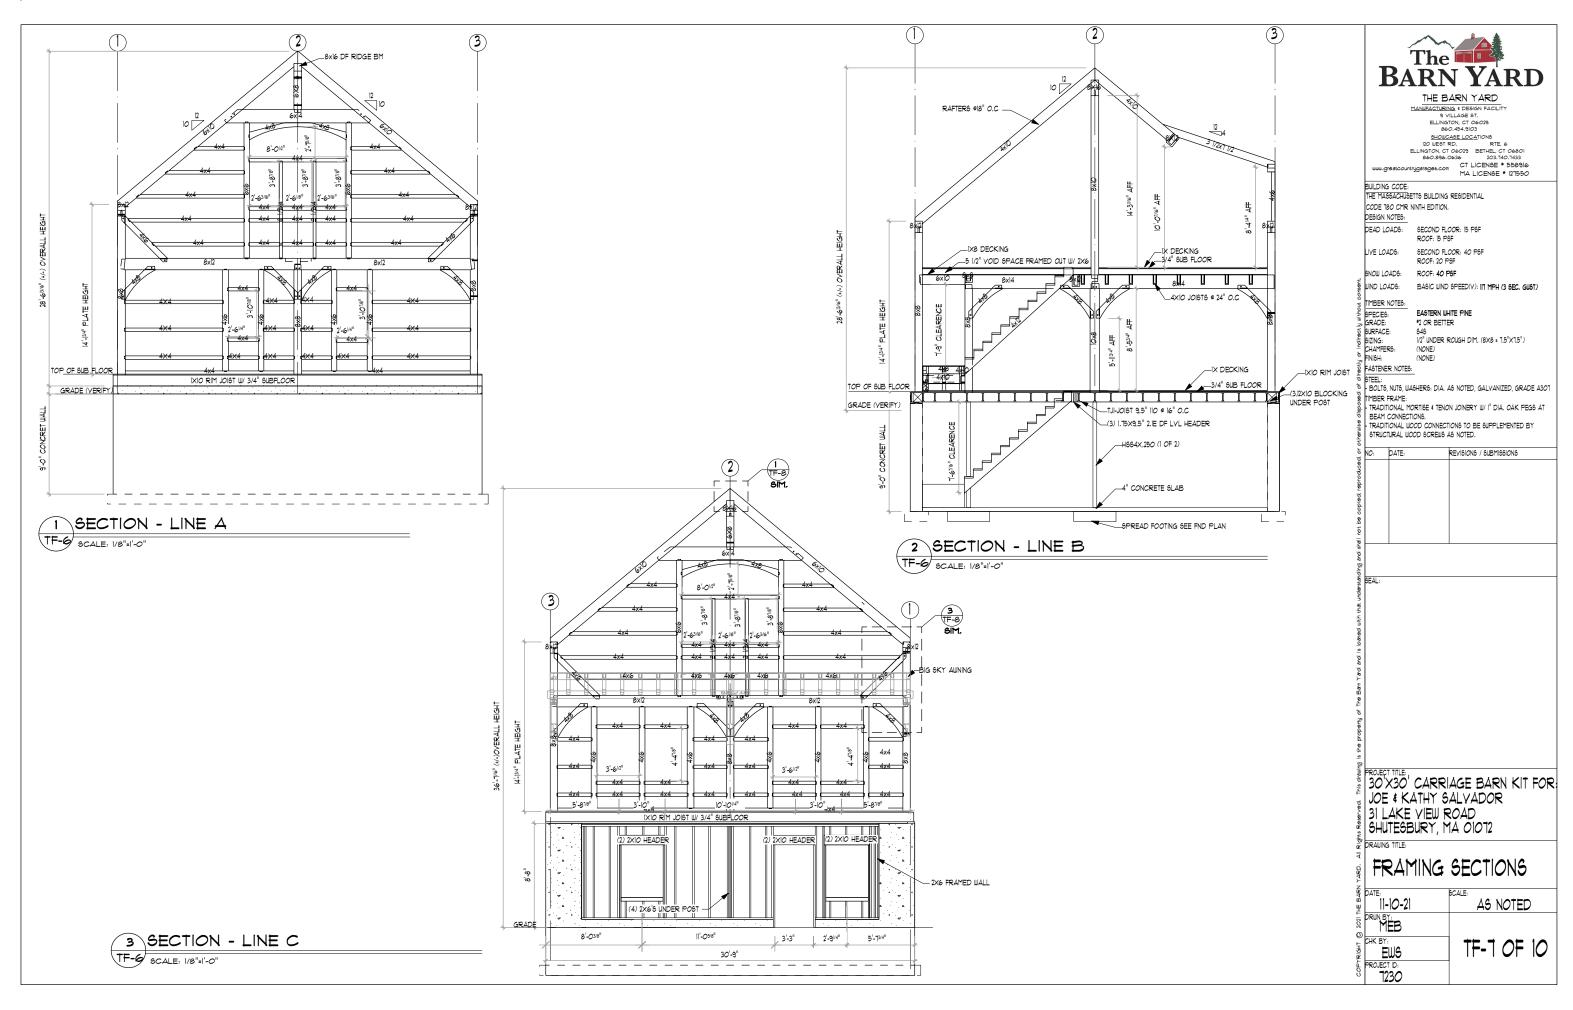

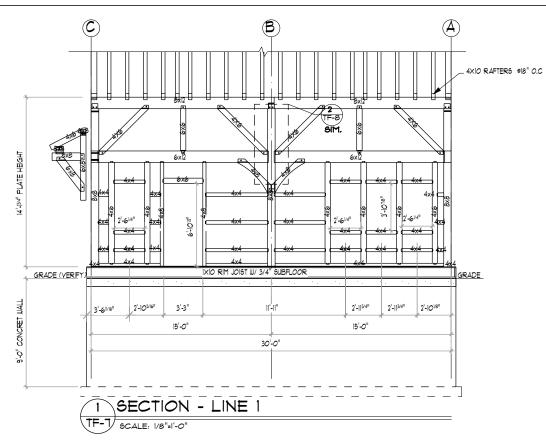

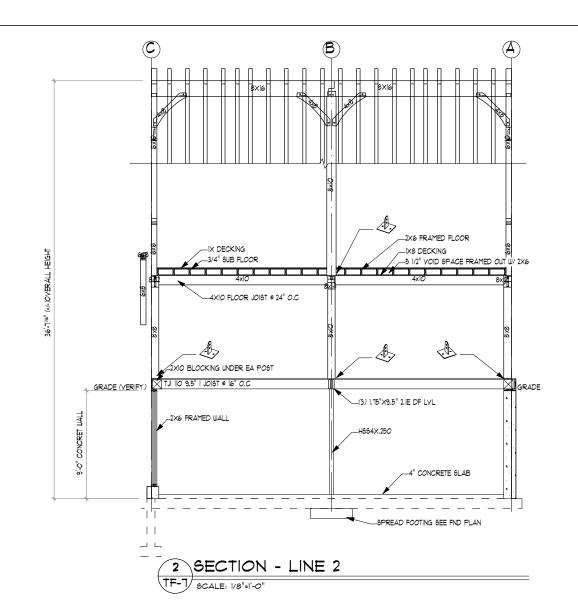



THE BARN YARD

MANUFACTURING 4 DESIGN FACILITY 9 VILLAGE ST. ELLINGTON, CT 06029 860, 454,9103

121560 | ### 121560 | ### 1

BULDING CODE: THE MASSACHUSETTS BUILDING RESIDENTIAL

CODE 180 CMR NINTH EDITION. DESIGN NOTES:

DEAD LOADS: SECOND FLOOR: 15 PSF ROOF: 15 PSF

LIYE LOADS: SECOND FLOOR: 40 PSF

ROOF: 20 PSF SNOW LOADS: ROOF: 40 PSF

MIND LOADS: BASIC WIND SPEED(V): IIT MPH (3 SEC. GUST)

TIMBER NOTES:

EASTERN WHITE PINE *2 OR BETTER

SPECIES:

6URFACE: 6URFACE: 6IZING: CHAMFER6: FINI6H: 646 1/2" UNDER ROUGH DIM. (6X6 = 1.5"X1.5")

FASTENER NOTES:

TEEL:

BOLTS, NUTS, WASHERS: DIA, AS NOTED, GALVANIZED, GRADE A301

BEAM CONNECTIONS, TRADITIONAL WOOD CONNECTIONS TO BE SUPPLEMENTED BY

STRUCTURAL WOOD SCREWS AS NOTED.

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PROJECT TITLE: 30 X30 CARRIAGE BARN KIT FOR: JOE & KATHY SALVADOR 31 LAKE VIEW ROAD SHUTESBURY, MA 01072

DRAWING TITLE:

FRAMING SECTIONS

z	
DATE: 11-10-21 RIUN BY: SS	AS NOTED
FINE EMS	TF-8 OF 10
FROJECT D:	

STRUCTURAL NOTES:

ALL WORK SHALL CONFORM TO THE CURRENT REQUIREMENTS OF THE MASSACHUSETTS BUILDING RESIDENTIAL CODE TRO CMR NINTH EDITION DIMENSIONS AND DETAILS SHALL BE CHECKED AGAINST ENGINEERING DRAWINGS.THE CONTRACTORSHALL VERIFY AND COORDINATE THE SIZE AND LOCATION OF ALL OPENINGS, SLEEVES AND ANCHOR BOLTS AS REQUIRED BY ALL TRADES OPENINGS NOT SPECIFICALLY SHOUN SHALL BE APPROVED BY THE ENGINEER, ALL WORK TO CONFORM TO ALL APPLICABLE LOCAL STATE AND NATIONAL

CODES AND REGULATIONS, AND THE OWNERS OR DESIGNATED CONTRACTORS SHALL SECURE APPROPRIATE PERMITS REQUIRED BEFORE COMMENCEMENT OF ACTUAL CONSTRUCTION. ALL CONTRACTORS, SUBCONTRACTORS, SUPPLIERS AND ALL OTHER PERSONS ENGAGED IN ANY CAPACITY ON THIS PROJECT SHALL BE SUBJECT TO PROVISIONS OF THE OSHA (OCCUPATIONAL SAFETY AND HEALTH ADMINISTRATION) WHICH IS ADMINISTERED AND ENFORCED BY U.S. DEPARTMENT OF HEALTH.

FOUNDATIONS:

ALL FOOTINGS SHALL BEAR ON UNDISTURBED NATURAL MATERIAL OR GRANULAR FILL. ELEVATIONS OF BOTTOM OF FOOTING SHOWN ON PLANS ARE FOR BIDDING PURPOSES AND SHALL BE LOWERED IF NECESSARY TO THE REQUIRED BEARING MATERIAL AS FOUND UPON EXCAYATION. IF THE REQUIRED BEARING MATERIAL IS NOT ENCOUNTERED AT ELEVATIONS SHOWN, NOTIFY ENGINEER IMMEDIATELY, CONTROLLED BACK FILL AND COMPACTION IF REQUIRED.

A. SCOPE: WHERE UNACCEPTABLE, MATERIAL MUST BE REMOVED AND REPLACED WITH PROPER MATERIAL, A CONTROLLED PROCEDURE MUST BE FOLLOWED TO ENSURE PROPER BEARING FOR THE BUILDING.

- B. FILLING AND GRADING: BEFORE BACK FILLING REMOVE CONSTRUCTION DEBRIS STUMPS TREES, ROOTS, SOD, HEAVY GRASS, DECAYED VEGETABLE MATTER AND OTHER UNSUITABLE MATERIALS, FILL MATERIAL SHALL BE AS APPROVED BY THE ENGINEER.
- C. CONSTRUCTION METHODS: AFTER DEPOSITING FILL OR BACK FILL IN 1 FOOT LIFTS WELL WASHED IN COMPACT TO THE FOLLOWING PERCENT OPTIMUM DENSITY,


THE DRY DENSITY AFTER COMPACTION SHALL NOT BE LESS THAN 95% OF THE DRY DENSITY FOR THAT SOIL WHEN TESTED IN ACCORDANCE WITH ASTM DISST. METHOD D. IN THIS TEST, MATERIALS RETAINED ON THE THREE-QUARTER SIEVE SHALL BE REPLACED WITH


MATERIAL RETAINED ON THE NO. 4 SIEVE, AS NOTED AS AN OPTION IN


THE SPECIFICATIONS FOR THIS TEST.

D. FIELD TESTS: PERFORM ONE FIELD DENSITY TEST FOR EACH SOURCE OF FILL MATERIAL PERFORMED IN ACCORDANCE WITH ASTM D1556 PERFORM STANDARD FIELD DENSITY TESTS EACH OF AN ACCURACY OF PLUS OR MINUS ONE PERCENT, IT SHALL BE THE CONTRACTORS RESPONSIBILITY TO NOTIFY THE ENGINEER AND TESTING LABORATORY WHEN EACH LAYER OF FILL IS TO BE PLACE AND READY FOR TESTING THE CONTRACTOR SHALL ALLOW AMPLE TIME FOR TESTING, IF ANY FILL IS PLACED IN EXCESS OF SIXTEEN (16) WITHOUT TESTING, IT SHALL BE SUBJECT TO REMOVAL, SIEVE ANALYSIS SHALL BE AT THE CONTRACTOR'S EXPENSE.

E. OBSERVATION: ALL EXCAVATION OF UNACCEPTABLE MATERIAL INSTALLATION OF CONTROLLED FILL, COMPACTION, FIELD TESTING AND LABORATORY TESTING SHALL BE DONE UNDER THE SUPERVISION OF A TESTING LABORATORY WHO SHALL PROVIDE WRITTEN REPORTS OF ALL PHASES OF THE WORK TO THE ENGINEER.

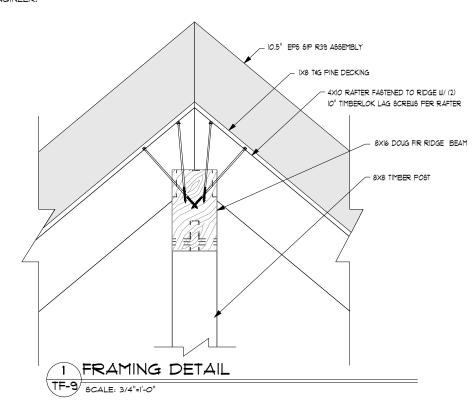

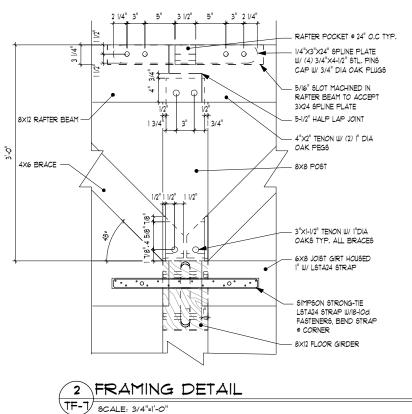

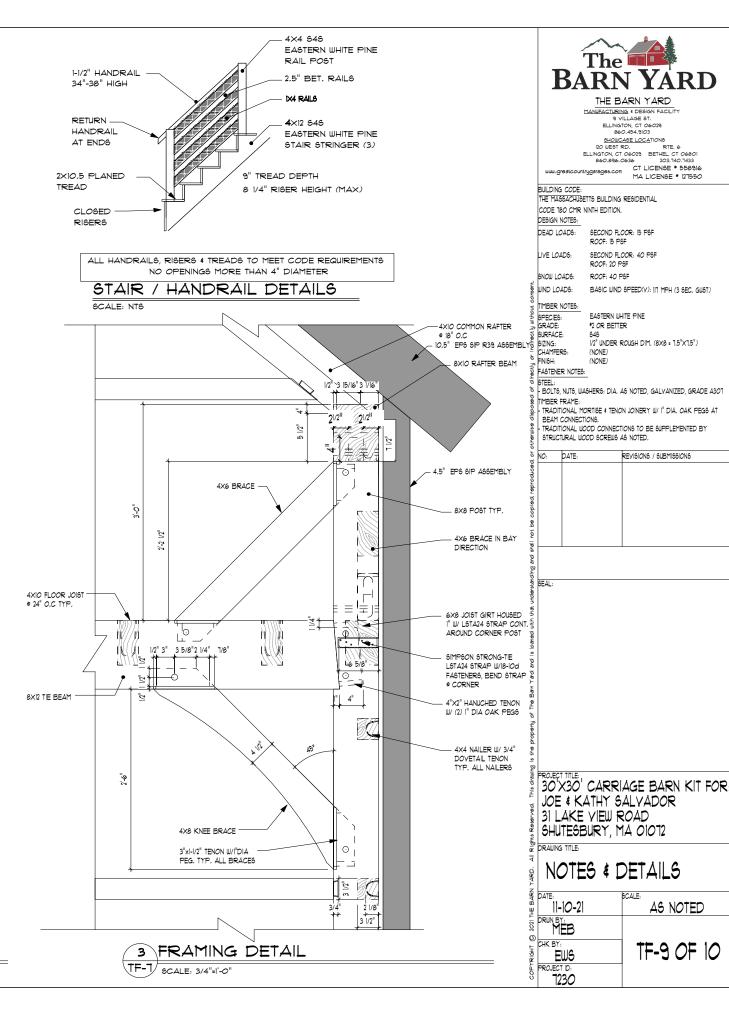

THE BARN YARD

MANUFACTURING & DESIGN FACILI

9 VILLAGE 9T. ELLINGTON, CT 06029 860.454.9103

SHOWCASE LOCATIONS

SECOND FLOOR: 15 PSF

SECOND FLOOR: 40 PSF

BASIC WIND SPEED(V): IIT MPH (3 SEC, GUST)

1/2" UNDER ROUGH DIM, (8×8 = 1,5"×1,5")

REVISIONS / SUBMISSIONS

AS NOTED

TF-9 OF 10

ROOF: 15 PSF

ROOF: 40 PSF

EASTERN WHITE PINE

*2 OR BETTER

R- value in chart below is SIP Equivalent or Whole Surface. Panels must actually be that or higher to meet code. For explaination of reasoning see FPI Tech Bulletins on Relevant code

This is FPI's best attempt at interpreting the relavant codes, local enforcement has the final say in all situations.

These are the codes accessed 8/17/2020 as per https://www.energycodes.gov/status-



TABLE R402.1.2 INSULATION AND FENESTRATION REQUIREMENTS BY COMPONENT^a

CLIMATE ZONE	FENESTRATION U-FACTOR ^b	SKYLIGHT ^b U-FACTOR	GLAZED FENESTRATION SHGC ^{b, c}	CEILING R-VALUE	WOOD FRAME WALL R-VALUE	MASS WALL R-VALUE	FLOOR R-VALUE	BA SEMENT [©] WALL <i>R</i> -VALUE	SLAB ^d R-VALUE & DEPTH	CRAWL SPACE ^C WALL R-VALUE
1	NR	0.75	0.25	30	13	3/4	13	0	0	0
2	0.40	0.65	0.25	36	13	1/6	13	0	0	0
3	0.35	0.55	0.25	38	20 or 13+5 ^h	8/13	19	5/13 ^f	0	5/13
4 except Marine	0.35	0.55	0.40	49	20 or 13+5 ^h	8/13	19	10/13	10, 2 ft	10/13
5 and Marine 4	0.32	0.55	NR	49	20 or 13+5 ^h	13/17	309	15/19	10, 2 ft	15/19
6	0.32	0.55	NR	49	20+5 or 13+10 ^h	15/20	309	15/19	10, 4 ft	15/19
7 and 8	0.32	0.55	NR	49	20+5 or 13+10 ^h	19/21	389	15/19	10. 4 ft	15/19

STRUCTURAL INSULATED PANELS



	Overall Thickness (in)	2.88	4.50	6.50	8.25	10.25	10.50	12.25	12.88	15.00	16.00
Coro	Thickness (in)	2.00	3.63	5.63	7.38	9.38	9.63	11.38	11.88	14.13	15.13
Core	T								Service Control	Constanting	
	U-value @75°	0.115	0.067	0.043	0.034	0.027	0.026	0.022	0.021	0.018	0.017
	R-Value @75°	8.7	15	23	29	37	38	45	47	55	59
	R-Value @40°	9.4	16	25	32	40	41	49	51	60	65
EPS	Permeance (perm)	.71	0.58	0.47	0.40	0.35	0.34	0.31	0.29	0.26	0.25
	Weight (lb/sqft)	3.0	3.1	3.3	3.4	3.6	3.6	3.7	3.8	4.0	4.1
	Size Availability 4ft Widths	4, 5, 6, 7, 8, 9, 10, 12, 14, 16, 18, 20, 22, and 24ft									
	Size Availability 8ft Widths	ns 8, 10, 12, 14, 16, 18, 20, and 24ft									
	U-value @75°	0.010	0.056	0.037	0.028	0.022	0.022	0.019	0.018	0.015	0.014
	R-Value @75°	10	18	27	36	45	46	54	57	67	72
	R-Value @40°	11	19	29	38	48	49	58	61	72	77
NEO	Permeance (perm)	0.61	0.46	0.36	0.30	0.25	0.24	0.21	0.21	0.18	0.17
	Weight (lb/sqft)	3.1	3.3	3.5	3.9	4.2	4.2	4.5	4.6	4.9	5.1
	Size Availability 4ft Widths	4, 5, 6, 7, 8, 9, 10, 12, 14, 16, 18, 20, 22, and 24ft									
	Size Availability 8ft Widths	8, 10, 12, 14, 16, 18, 20, and 24ft									
	U-value @75°	0.083	0.043	0.029	0.023	0.018	-	0.015	-	-	-
PIR	R-Value	12	23	34	44	56	*	67	-	*	
	Permeance (perm)	0.33	0.22	0.15	0.12	0.10	-	0.08	-	-	140
	Weight (lb/sqft)	3.1	3.4	3.7	4.0	4.4		4.7		-	-
	Size Availability 4ft Widths	4, 5, 6, 7, 8, 9, 10, 12, 14, 16, 18, 20, 22, and 24ft									
	Size Availability 8ft Widths	8, 10, 12, 14, 16, 18, 20, and 24ft									



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9 VILLAGE ST.
ELLINGTON, CT 06029
860.454.9103

121560 | ### 121560 | ### 1

BUILDING CODE: THE MASSACHUSETTS BUILDING RESIDENTIAL CODE 180 CMR NINTH EDITION. DESIGN NOTES:

DEAD LOADS:

SECOND FLOOR: 15 PSF ROOF: 15 PSF LIVE LOADS:

SECOND FLOOR: 40 PSF

SNOW LOADS: ROOF: 40 PSF

MIND LOADS: BASIC WIND SPEED(V): ||17 MPH (3 SEC. GUST)

TIMBER NOTES:

EASTERN WHITE PINE *2 OR BETTER

SPECIES: STADE:
SURFACE:
SUZING:
CHAMFERS:
FINISH:
FASTENER NOTES: 545 1/2" UNDER ROUGH DIM, (8X8 = 1.5"X1.5")

BEAM CONNECTIONS.

TRADITIONAL WOOD CONNECTIONS TO BE SUPPLEMENTED BY STRUCTURAL WOOD SCREWS AS NOTED.

REVISIONS / SUBMISSIONS

ROJECT TITLE: 30'X30' CARRIAGE BARN KIT FOR: JOE & KATHY SALYADOR 31 LAKE VIEW ROAD SHUTESBURY, MA 01072

DRAWING TITLE:

3D RENDERING

PATE: BCALE: 11-10-21 DRUMBY: MER	AS NOTED
0 1125	F-10 OF 10