


NOTES:

1. THE PROPERTY LINES SHOWN WERE DETERMINED BY AN ACTUAL FIELD SURVEY CONDUCTED BY DANIEL SALLS SURVEYING. THE TOPOGRAPHY AND PHYSICAL FEATURES ARE BASED ON AN ACTUAL FIELD SURVEY PERFORMED ON THE GROUND BY DANIEL SALLS SURVEYING, DURING SEPTEMBER 2020. THE LOCATION OF PRIVATE WATER SUPPLY WELLS NOT LOCATED BY DANIEL SALLS SURVEYING AND THE LOCATION OF ON-SITE SEWAGE DISPOSAL SYSTEMS WERE ADDED BASED ON RECORD (REC) INFORMATION.

LOCUS PLAN: NOT TO SCALE

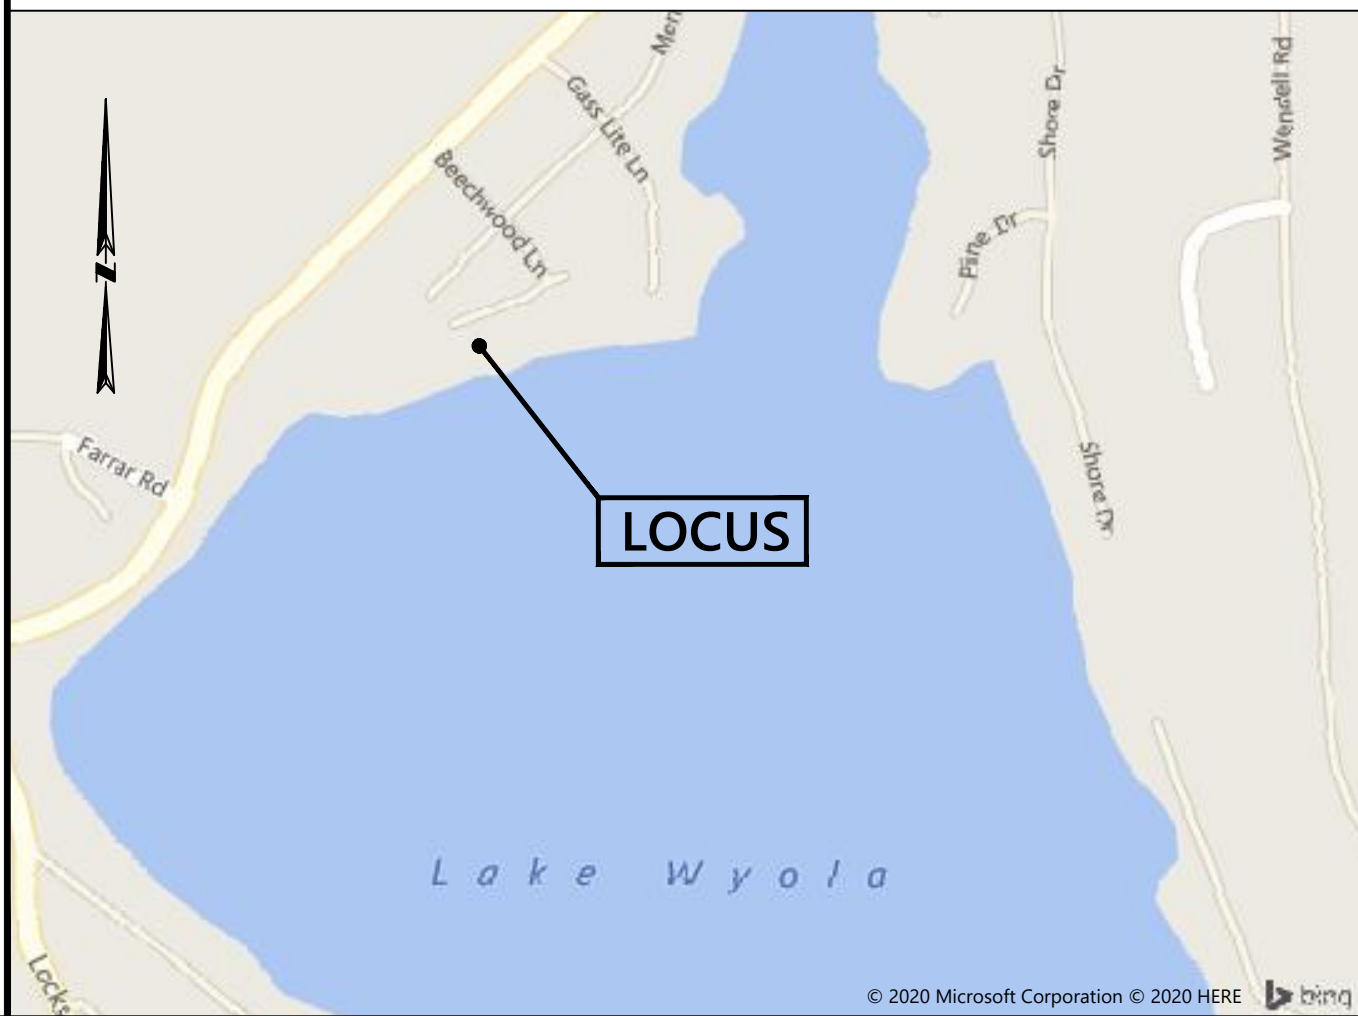

Wetland Buffer Zone Mitigation Plantings Table

SYMBOL	LATIN NAME	COMMON NAME	INDICATOR STATUS	PLANT TYPE	NUMBER OF PLANTINGS	SIZE	SUGGESTED SPACING
VC	<i>Vaccinium corymbosum</i>	HIGHBUSH BLUEBERRY	FACW	SHRUB	5	2-3 FT	3 FT ON CENTER
AR	<i>Acer rubrum</i>	RED MAPLE	FAC	TREE	2	1 IN CALIPER	20 FT ON CENTER

16 WYOLA DRIVE

IN
SHUTESBURY
MASSACHUSETTS
(FRANKLIN COUNTY)

SITE PLAN

DECEMBER 3, 2020

REVISIONS:		
NO.	DATE	DESC.
1	12/17/20	ADD PLANTINGS

Petrin
Engineering

33 Lee Road
South Deerfield, Massachusetts
01373

413 397 3059



MICHAEL R. PETRIN
PROFESSIONAL ENGINEER

DATE

PREPARED FOR:
MATTHEW & MELISSA BOROWIEC
178 FIELDS HILL ROAD
CONWAY, MASSACHUSETTS
01341

SCALE: AS SHOWN
0 10 20 40 FEET

DESIGN: M. PETRIN

SURVEY: D. SALLS

FILE: \0005.00 sep.dwg

DWG. NO: 0005-2

JOB. NO: 0005.00

SHEET 1 OF 1